




# Drawing for Insulation Paneling (ANNEX-B)

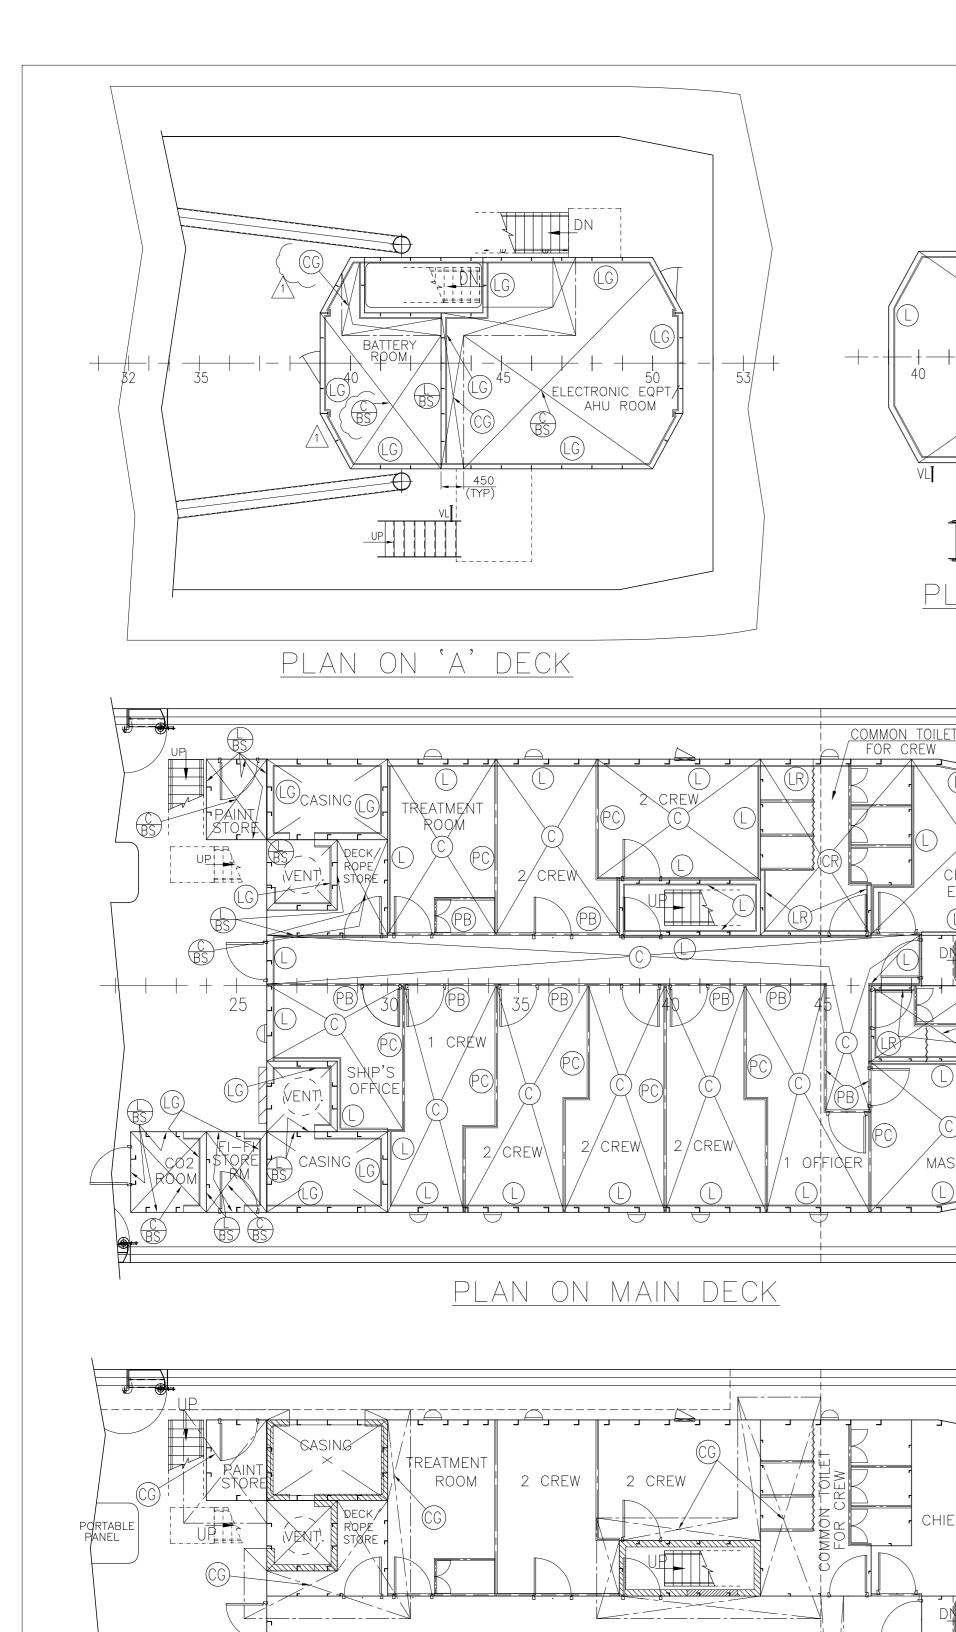

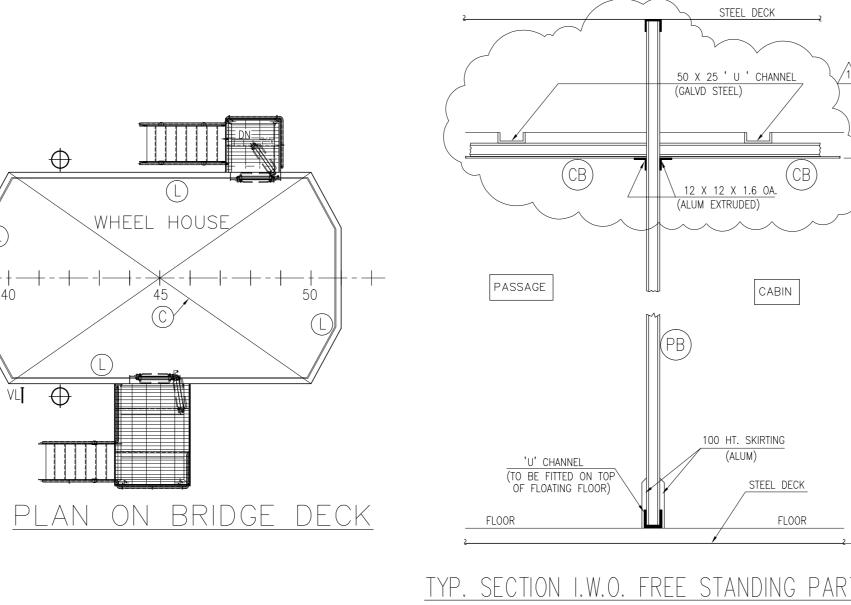

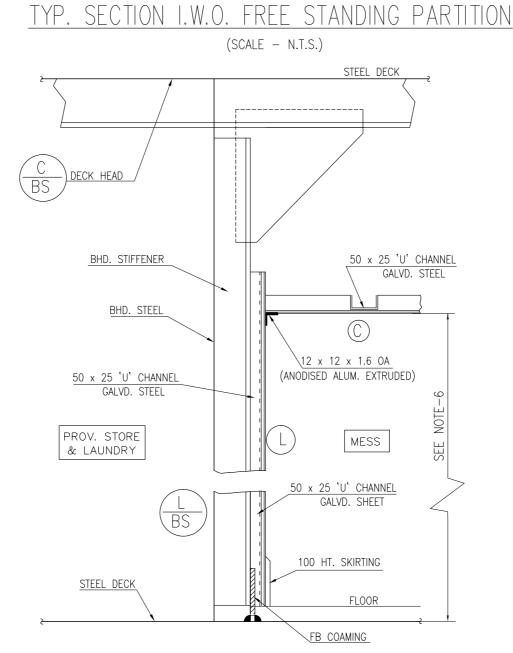

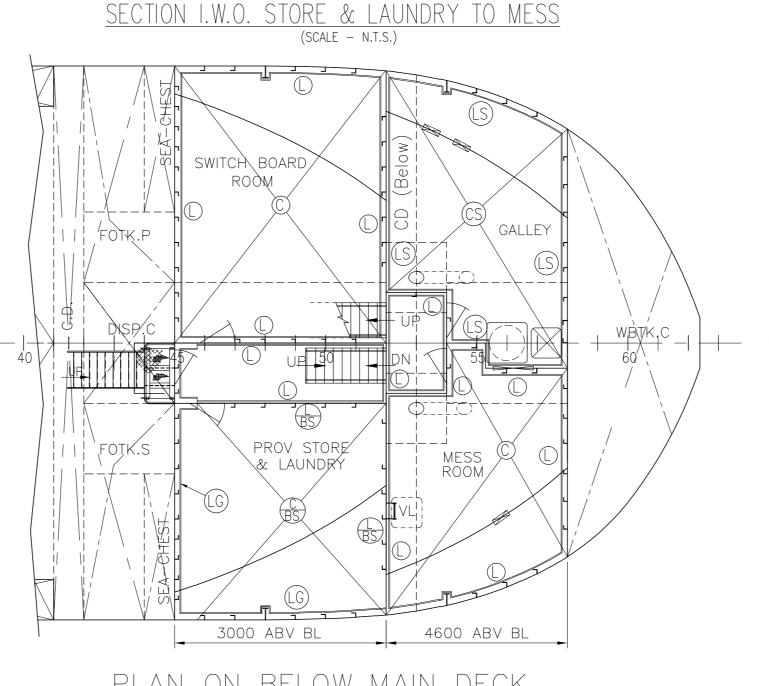

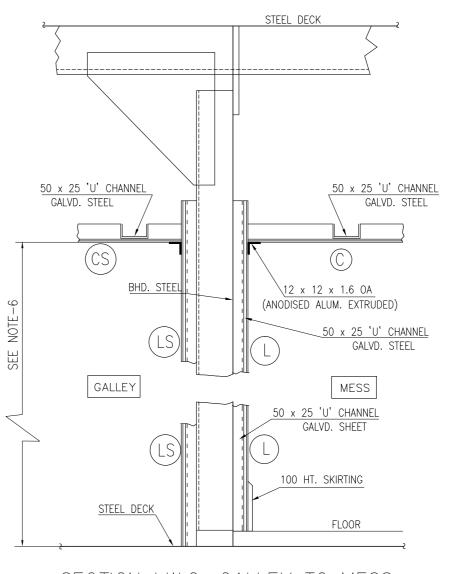

# SECTION I.W.O. GALLEY TO MESS

(SCALE - N.T.S.)

## CLASS COMMENTS

- 1. BULKHEADS REQUIRED TO BE B CLASS DIVISIONS SHALL EXTEND FROM DECK TO DECK AND TO THE SHELL OR OTHER BOUNDARIES. HOWEVER, WHERE A CONTINUOUS B CLASS CEILING OR LINING IS FITTED ON BOTH SIDES OF THE BULKHEAD, THE BULKHEAD MAY TERMINATE AT THE CONTI-NUOUS CEILING OR LINING ( NR467, PtC, CH4, SEC5 [1.4.2.a]). CEILING PANELS INDICATED ON 'FREE STANDING PARTITION' DETAIL ARE TO BE B CLASS. THE B CLASS BULKHEAD IS TO BE EXTENDED FROM B CLASS CEILING TO DECK.
- 2. FIRE INTEGRITY IS NOT TO BE IMPAIRED IN WAY OF WINDOW CASINGS.
- 3. IN MACHINERY SPACES WHERE PENETRATION OF OIL PRODUCTS IS POSSIBLE, THE SURFACE OF IGNITION ARE TO BE IMPERVIOUS TO OIL AND OIL VAPOURS (NR467, PtC, Ch4, SEC 6, [4.1.1.d])
- 4. SURFACES AND GROUNDS IN CONCEALED OR INACCESSIBLE SPACES IN ACCOMMODATION AND SERVICE SPACES AND CONTROL STATIONS ARE TO HAVE LOW FLAME SPREAD CHARACTERISTICS IN ACCORDANCE WITH THE FIRE TEST PROCEDURES CODE (e.g. PLASTIC LAMINATE).
- 5. RESTRICTED USE OF COMBUSTIBLE MATERIALS IS TO BE IN COMPLIANCE WITH NR467, PTC, CH4, SEC2, §2.2.1 & §2.2.2 (E.G. PLASTIC LAMINATE,
- TOTAL VOLUME OF COMBUSTIBLE MATERIALS, ETC.). 6. FOR FIRE INSULATION REQUIREMENTS SEE DRAWING 01-22 H28 - STRUCTURAL FIRE PROTECTION PLAN.
- 7. SURFACES AND GROUNDS IN CONCEALED OR INACCESSIBLE SPACES IN ACCOMMODATION AND SERVICE SPACES AND CONTROL STATIONS ARE TO HAVE LOW FLAME SPREAD CHARACTERISTICS IN ACCORDANCE WITH THE FIRE TEST PROCEDURES CODE (E.G. PLASTIC LAMINATE).
- 8. FIRE CLASS BULKHEAD, DECKS, DOORS, FIRE CLASS WINDOWS AND SIDE SCUTTLES, SURFACE MATERIALS, INSULATION MATERIALS, PRIMARY DECK COVERING AND CABLE PENETRATIONS ARE TO BE TYPE APPROVED BY THE

<u>PLAN I.W.O.</u>

BOW THRUSTER

(1500 A/B)

	SYMBOL	MATERIAL
	C	- 10 MM THICK NON COMBUSTIBLE BOARD FACED AT BOTH SIDES WITH 1.5 THK. PLASTIC LAMINATE.
	(CB)	- 50 MM THK. MARINE PANEL CONSISTING OF DOUBLE STEEL SHEET WITH GLASSWOOL OR EQUIVALENT INSULATION IN BETWEEN FACED WITH 1.5 THK. DECORATIVE FOIL ON BOTH SIDES OR EQUIVALENT FOR 'BO' CLASS STANDARD.
9	CR	- 10 MM THICK NON COMBUSTIBLE WATER RESISTANT BOARD FACED AT BOTH SIDES WITH 1.5 THK PLASTIC LAMINATE.
CEILING	CS	<ul><li>22 SWG STAINLESS STEEL SHEET.</li><li>50 X 20 'U' CHANNEL FOR SUPPORTING.</li></ul>
	CG	– THIN GAUGE PERFORATED GALVANISED STEEL SHEET OR EQUIV.
	C BS	- CEILING TO BE BARE STEEL - PAINTED. (COLOUR TO OWNER CHOICE)
	L	- 16 MM THICK NON COMBUSTIBLE BOARD FACED AT BOTH SIDES WITH 1.5 THK. PLASTIC LAMINATE.
	LS	- 22 SWG STAINLESS STEEL SHEET.
	LG	- 1.0 MM THK PERFORATED GALVANISED STEEL SHEET- PAINTED.
	(LR)	- 16 MM THICK NON COMBUSTIBLE WATER RESISTANT BOARD FACED AT BOTH SIDES WITH 1.5 THK. PLASTIC LAMINATE.
TINING		ALL LINING TO BE SECURED WITH:  - 50 x 20 'U' CHANNEL FOR SUPPORTING  BOARD / GALV. SHEET / S.S. SHEET.  - POP. RIVET OR CSK. SCREW AT EVERY  250 MM APART FOR (LG) AND (LS)  - ANGLE STRIP BETWEEN LINING / CEILING.  - SKIRTING BETWEEN LINING / FLOOR.  - OR VENDOR'S STANDARD METHOD APPROVED BY SURVEYOR.
	L BS	BARE STEEL PAINTED — NO LINING. (COLOUR TO OWNER CHOICE)
PARTITION	(PB)	<ul> <li>50 MM THK. MARINE PANEL CONSISTING OF DOUBLE STEEL SHEET WITH GLASSWOOL OR EQUIVALENT INSULATION IN BETWEEN FACED WITH 1.5 THK. DECORATIVE FOIL ON BOTH SIDES OR EQUIVALENT FOR 'BO' CLASS STANDARD.</li> <li>50 X 20 'U' CHANNEL FOR SUPPORTING BOARD.</li> <li>ANGLE STRIP BETWEEN LINING / CEILING.</li> <li>SKIRTING BETWEEN LINING / FLOOR.</li> <li>OR VENDOR'S STANDARD METHOD APPROVED BY SURVEYOR.</li> </ul>
	PC	- 50 MM THK MARINE BOARD WITH DECORATIVE FOIL ON BOTH SIDES TO 'C' CLASS STANDARD.

# NOTE :-

- 1) ALL PAINT SHALL NOT OFFER UNDUE FIRE HAZARD AND SHALL NOT BE CAPABLE OF PRODUCING EXCESSIVE QUANTITIES OF SMOKE.
- 2) ALL MATERIAL, FOR USE IN LINING, PARTITION, TO BE APPROVED BY MARITIME ADMINISTRATION. SURFACE COVERING TO BE TYPE APPROVED (LOW FLAME SPREAD CHARACTERESTICS).
- 3) ALL BULKHEADS, WHERE NOT REQUIRED TO BE 'A' OR 'B' CLASS BEING AT LEAST 'C' CLASS CONSTRUCTION.
- 4) COPIES OF CERTIFICATES APPROVED BY THE NATIONAL AUTHORITIES IN RESPECT OF ALL 'A', 'B' & 'C' CLASS FIRE DIVISIONS, NOT-COMBUSTIBLE MATL. & MATERIAL HAVING LOW FLAME SPREAD CHARACTERISTICS. ETC. WHICH ARE TO BE USED BEING SUBMITTED.
- 5) PRIMARY DECK COVERING BEING OF AN APPROVED MATERIAL WHICH WILL NOT READILY IGNITE OR GIVE RISE TO TOXIC OR EXPLOSIVE HAZARDS AT ELEVATED TEMPERATURES.
- 6) THROUGHOUT THE ACCOMMODATION THE FREE HEIGHT SHALL NOT BE LESS THAN 2050 mm INCLUDING LIGHTING ORNAMENTS.
- 7) ALL ACCOMMODATION PANELS SHALL BE ERECTED TO MANUFACTURER'S STANDARD STEEL PROFILES. PORTABLE PANELS TO BE FITTED WHERE CABLE RUNS, REMOTE CONTROL LINES, AIR TRUNKING OR OTHER ITEMS ARE CONCEALED BY THE LINING FOR WHICH ACCESS FOR MAINTENANCE AT LATER STAGE IS REQUIRED.
- 8) THIS IS TO BE READ WITH <u>STRUCTURAL FIRE PROTECTION PLAN. DWG. NO. 01/22-H28</u>

## Bureau Veritas Marine & Offshore Section 42215N / 42216P **REVIEWED** subject to comments and only for parts concerning Classification, and as per contract. Istanbul, 17-Jan-2023

[Electronic document]

The plan approval office

See comments in VPM

INSULATION PLAN UNDERSIDE OF MAIN DECK						
	INSULATION	PLAN	UNDERSIDE	OF	MAIN	DECK

BY REV DESCRIPTION OF ALTERATION

2 CREW 2 CREW 1 OFFICERI

1 CREW

REVIEWED BY CLASS (LP02040573, LP02040574, LP02040575, 20.12.22 | Partha

LP02040576, LP02040565, LP02040566, LP02040567)

DATED 08 Dec 2022.

REV DESCRIPTION OF ALTERATION

2 CREW

/MASTER

CHIEF. ENG.

MASTER

DATE


F'CLE DECK


V  /  V
111 V
ON DLLOW


- 1. ALL STEEL MATERIAL ARE BV GRADE-A UNLESS STATED OTHERWISE. 2. YARD IS ADVISED NOT TO FABRICATE UNTIL DWG. IS APPROVED BY CLASS.
- 3. "HOLD" MARK ON DWG. INDICATES CLASS APPROVAL PENDING.


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CHECKED : NAV	CLIENT'S HULL NO. : NB786 & NB787	TITLE :
DATE : 18.10.22		LINING/PARTITION & CE BUILDER :
APPROVED BY CLASS DA	TED : 08.12.2022	KHULNA SHIPYARD LIMITED
APPROVED BY OWNER D	ATED :	OWNER: PAYRA PORT AUTHORITY,


N :	Partha	SCALE : 1 : 75	PROJECT : 70T BOLLARD PULL TUG	DESIGNER:
KED	: NAV	CLIENT'S HULL NO. : NB786 & NB787	TITLE :	NAVNAUTIK PTE LTD naval architects, marine engineers & marine surveyors.
:	18.10.22		LINING/PARTITION & CEILING PLAN BUILDER:	540 SIMS AVENUE TEL: +65 67417220 #02-04 SIMS AVE CENTRE FAX: +65 67417219
OVED BY CLASS DATED : 08.12.2022		TED : 08.12.2022	KHULNA SHIPYARD LIMITED, BANGLADESH	SINGAPORE 387603 E—mail: NPL@navnautik.com or navnautik@gmail.com
OVED BY OWNER DATED :		ATED :	OWNER: PAYRA PORT AUTHORITY, BANGLADESH	DRG. NO. : 01/22-H29 (SHT 1 OF 1 ) REV :1

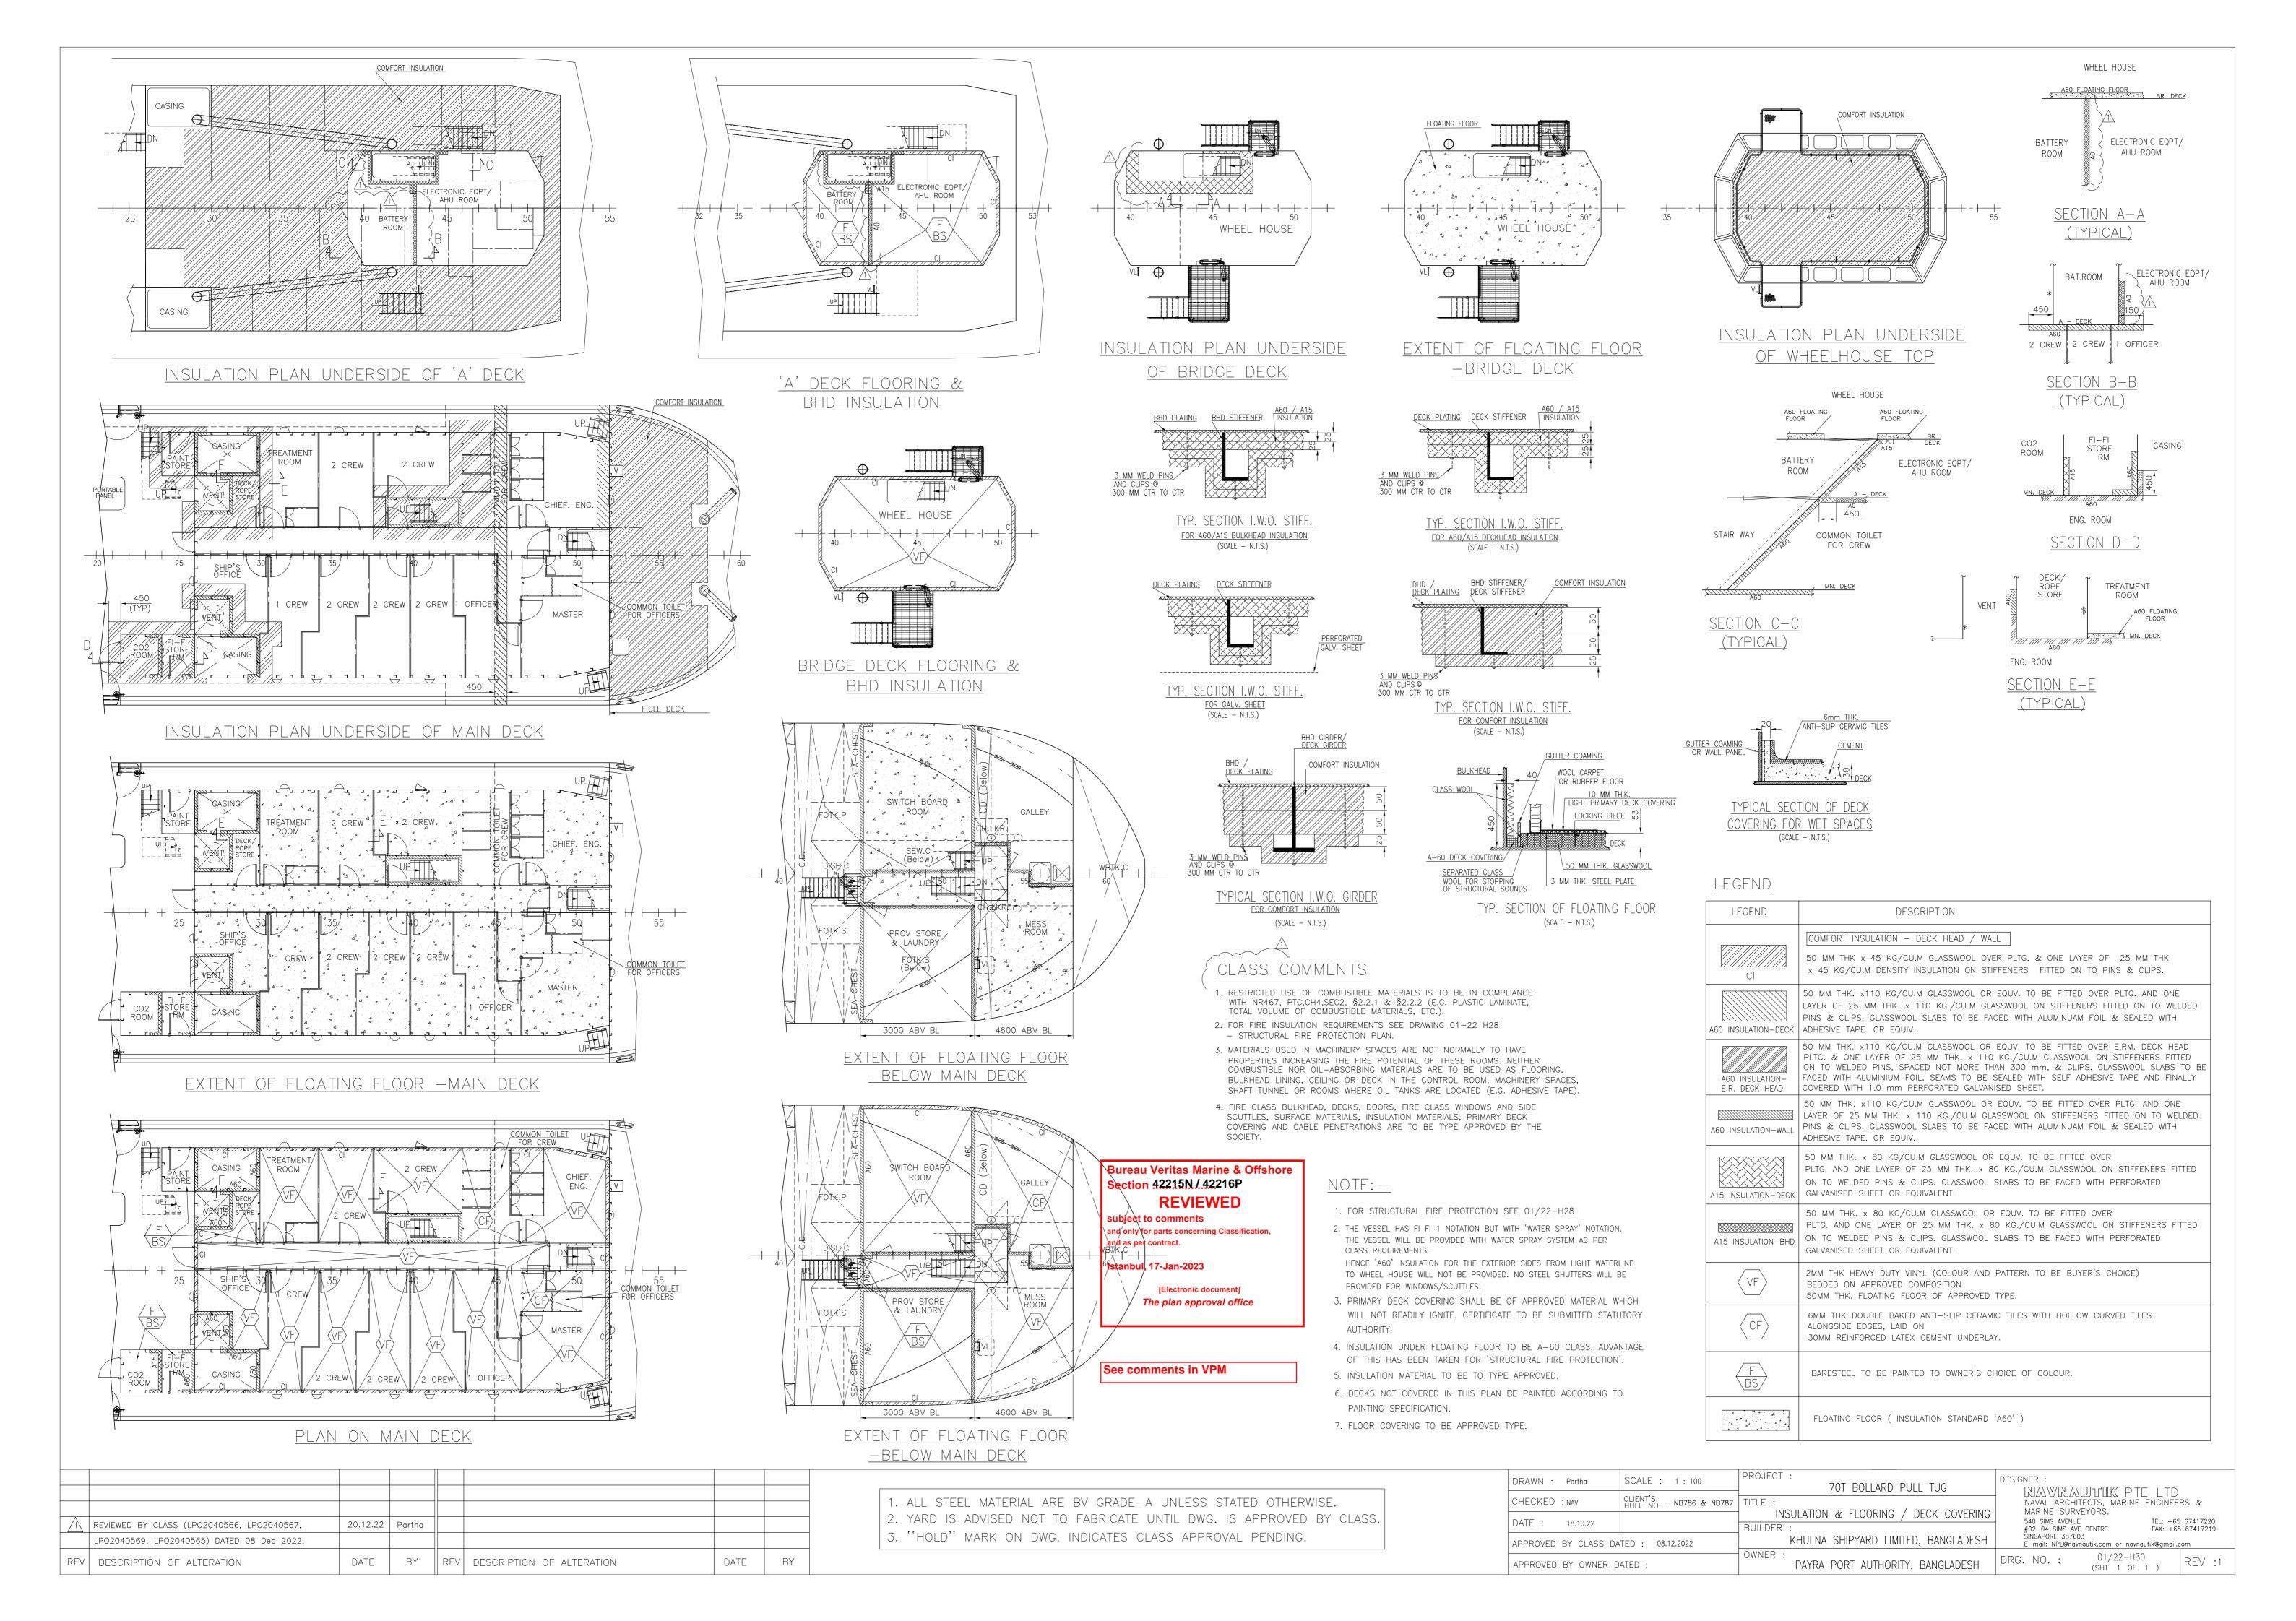


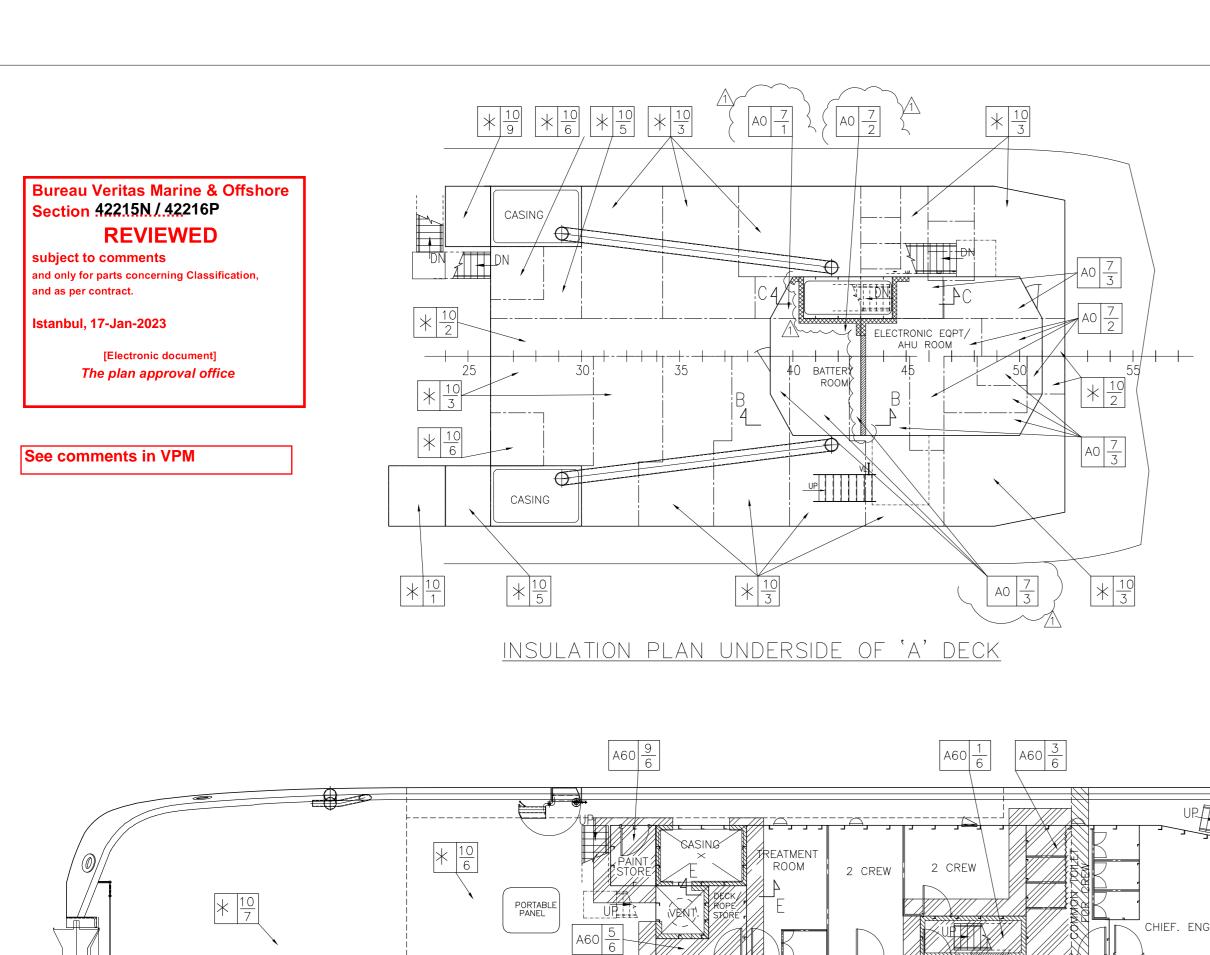

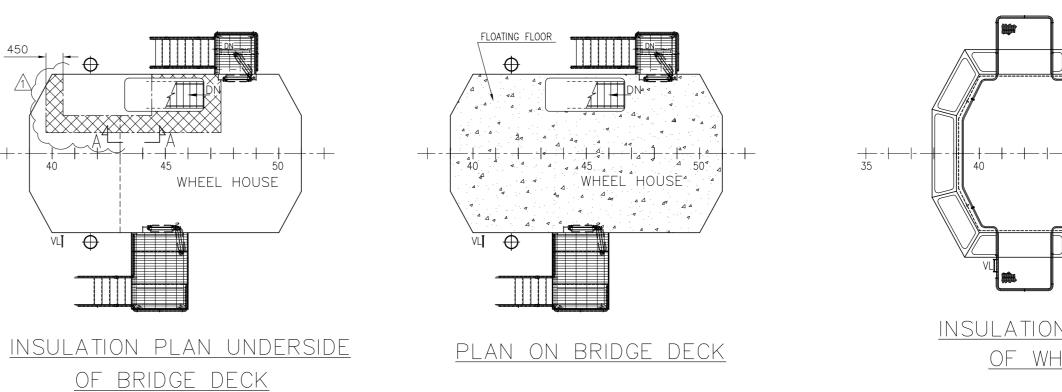

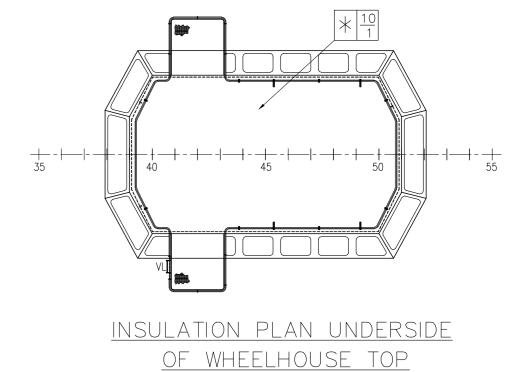

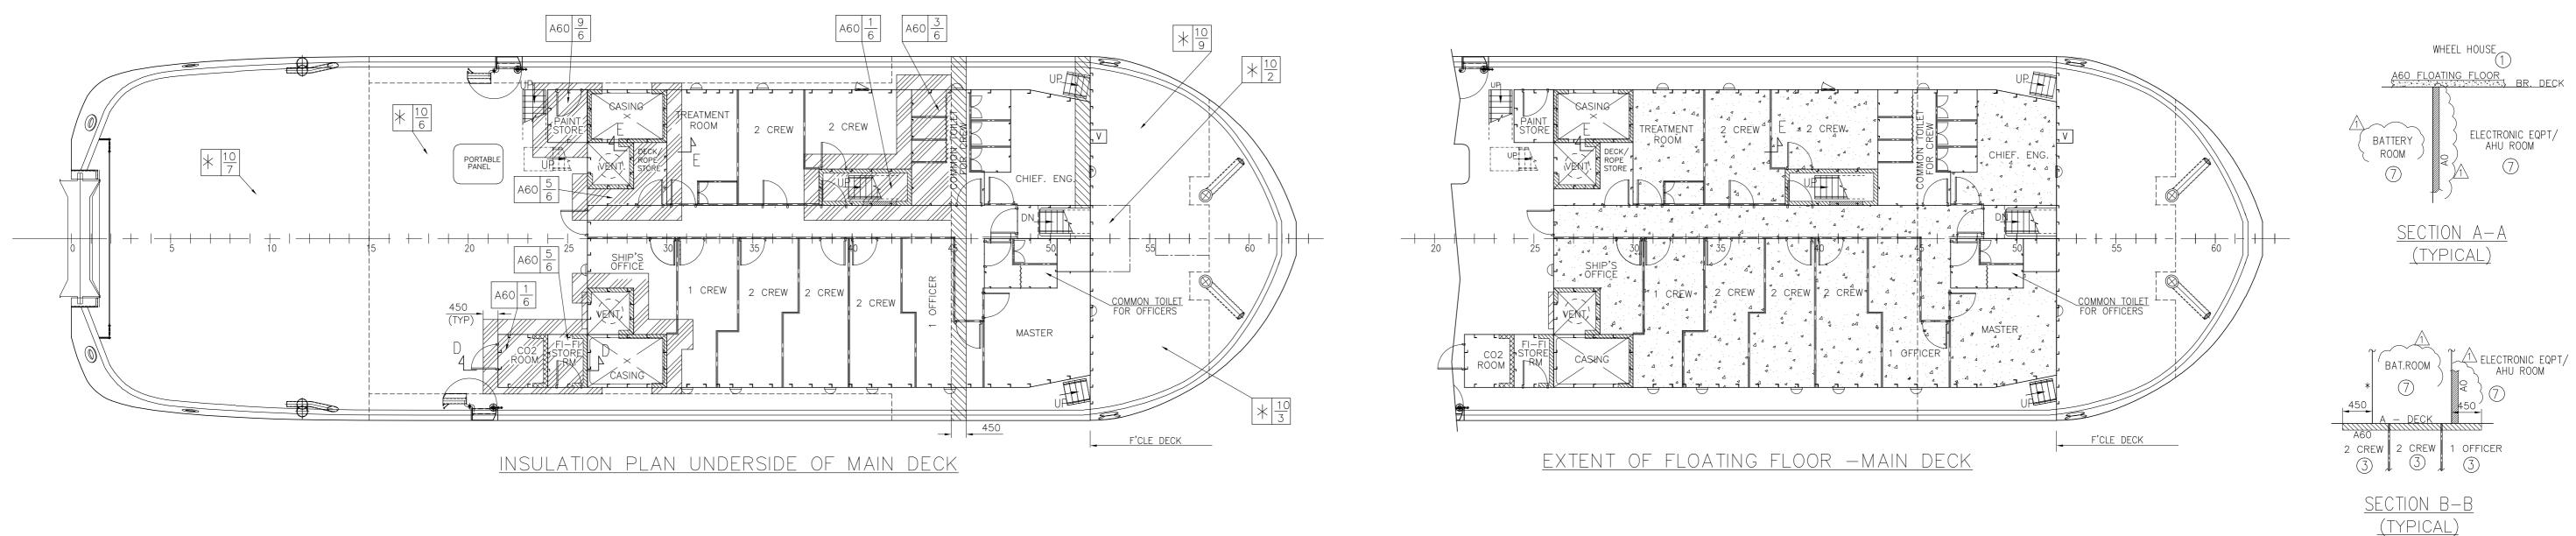

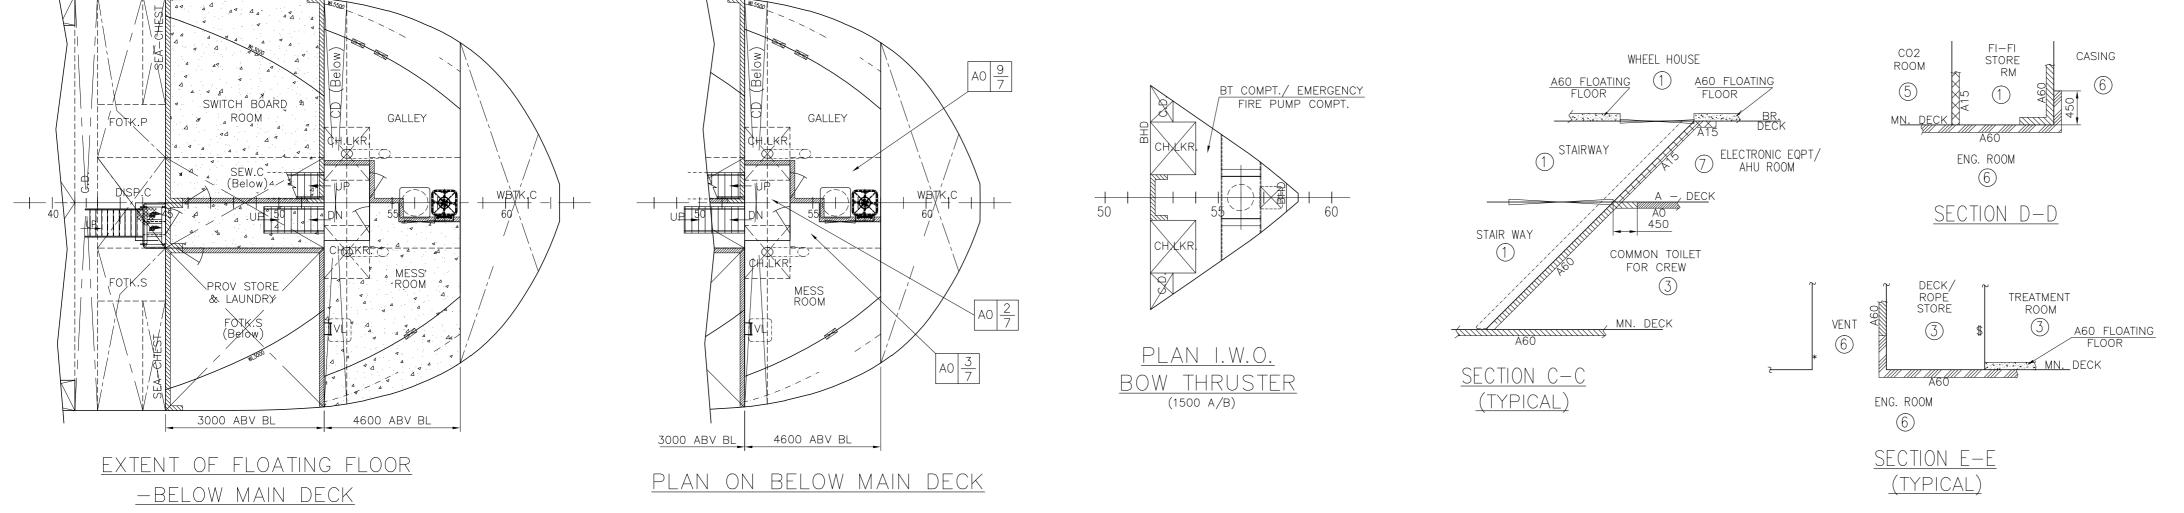


SYMBOL	DESCRIPTION
A60 INSULATION-DECK  A60 INSULATION-WALL	A60 INSULATION - DECK HEAD / WALL  50 MM THK. x110 KG/CU.M GLASSWOOL OR EQUV. TO BE FITTED OVER PLTG. AND ONE LAYER OF 25 MM THK. x 110 KG./CU.M GLASSWOOL ON STIFFENERS FITTED ON TO WELDED PINS & CLIPS.  GLASSWOOL SLABS TO BE FACED WITH ALUMINUAM FOIL & SEALED WITH ADHESIVE TAPE. OR EQUIV
	A60 INSULATION — ENGINE ROOM DECK HEAD  50 MM THK. x110 KG/CU.M GLASSWOOL OR EQUV. TO BE FITTED OVER E.RM. DECK HEAD PLTG. & ONE LAYER OF 25 MM THK. x 110 KG./CU.M GLASSWOOL ON STIFFENERS FITTED ON TO WELDER PINS, SPACED NOT MORE THAN 300 mm, & CLIPS. GLASSWOOL SLABS TO BE FACED WITH ALUMINIUM FOIL, SEAMS TO BE SEALED WITH SELF ADHESIVE TAPE AND FINALLY COVERED WITH 1.0 mm PERFORATED GALVANISED SHEET.
A15 INSULATION—DECK  A15 INSULATION—WALL	A15 INSULATION — DECK HEAD / WALL  50 MM THK. x 80 KG/CU.M GLASSWOOL OR EQUV. TO BE FITTED OVER PLTG. AND ONE LAYER OF 25 MM THK. x 80 KG./CU.M GLASSWOOL ON STIFFENERS FITTED ON TO WELDED PINS & CLIPS. GLASSWOOL SLABS TO BE FACED WITH PERFORATED GALVANISED SHEET. OR EQUIVALENT.
*	REQD. TO BE STEEL OR OTHER EQUEV. MATL. BUT IS NOT REQD. TO BE "A" CLASS STANDARD.
	FLOATING FLOOR ( INSULATION STANDARD 'A60' )


1	REVIEWED BY CLASS (LP02040577, LP02040579,	20.12.22	Partha					
	LP02040580, LP02040581, LP02040565)							
	DATED 08 Dec 2022.							
REV	DESCRIPTION OF ALTERATION	DATE	BY	REV	DESCRIPTION OF ALTERATION	DATE	BY	

- 1. ALL STEEL MATERIAL ARE BV GRADE—A UNLESS STATED OTHERWISE.
- 2. YARD IS ADVISED NOT TO FABRICATE UNTIL DWG. IS APPROVED BY CLASS.
  3. "HOLD" MARK ON DWG. INDICATES CLASS APPROVAL PENDING.


DRAWN : Partha	SCALE : 1 : 100	PROJECT :	70T BOLLARD PULL TUG	DESIGNER :	MTMK PTE LTD	
CHECKED : NAV	CLIENT'S HULL NO. : NB786 & NB787				ECTS, MARINE ENGINEE	
DATE : 18.10.22		SIR	RUCTURAL FIRE PROTECTION PLAN	540 SIMS AVENUE		67417220
DATE: 18.10.22		BUILDER :		#02-04 SIMS AVE	CENTRE FAX: +65	67417219
APPROVED BY CLASS DATED : 08.12.2022		KHU	LNA SHIPYARD LIMITED, BANGLADESH	SINGAPORE 387603 E-mail: NPL@navno	autik.com or navnautik@gmail.c	om
APPROVED BY OWNER D	ATED :	OWNER : PAY	YRA PORT AUTHORITY, BANGLADESH	DRG. NO. :	01/22-H28 (SHT 2 OF 2 )	REV :1


# Drawing for Mechanical Ventilation (ANNEX-C)

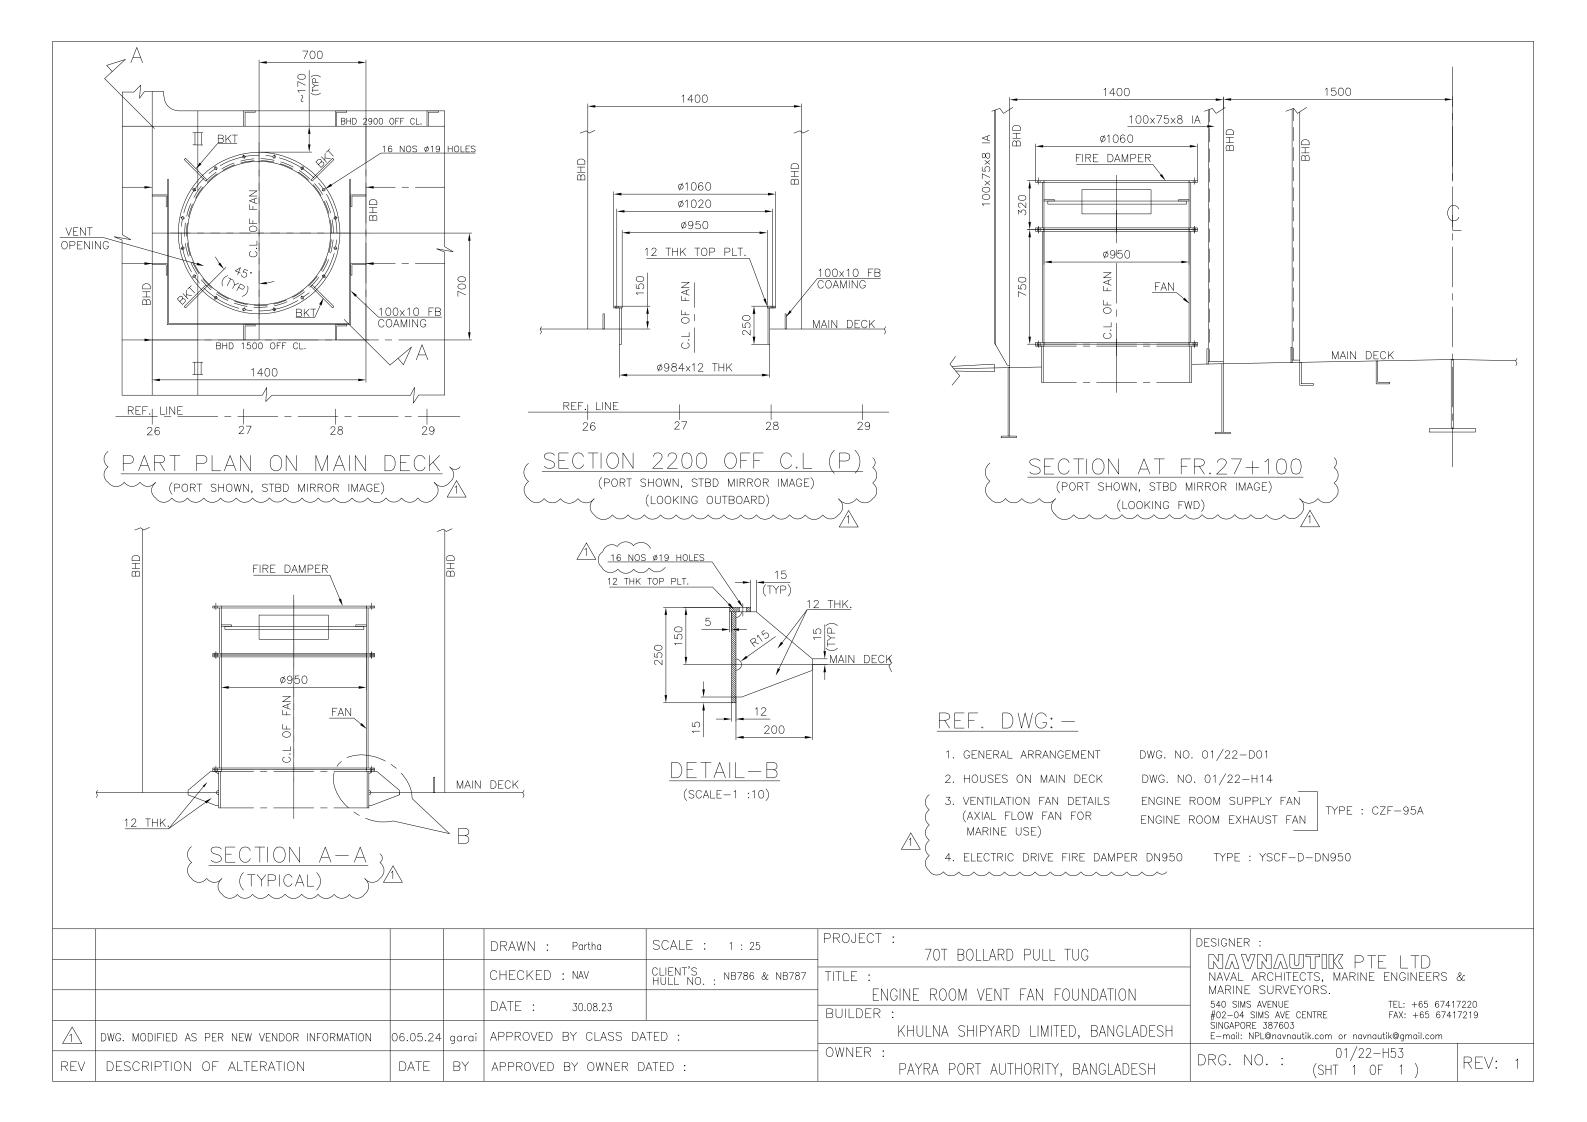

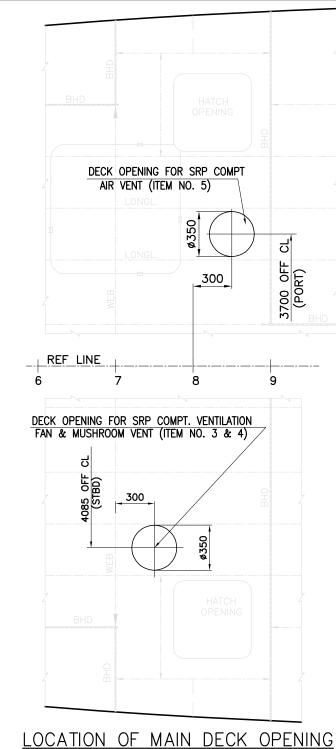




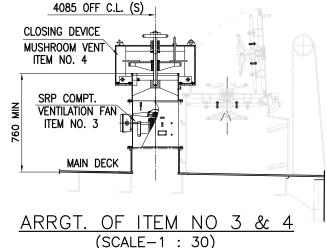

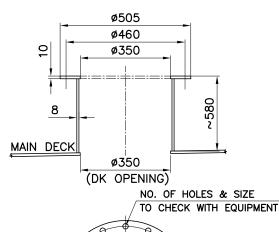





(SCALE - 1:15)

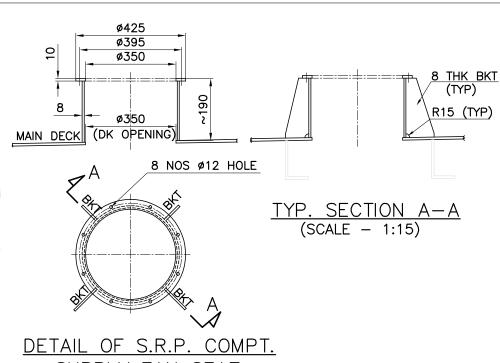

SUPPLY FAN SEAT (FOR ITEM NO. 3 & 4) (SCALE - 1:15)

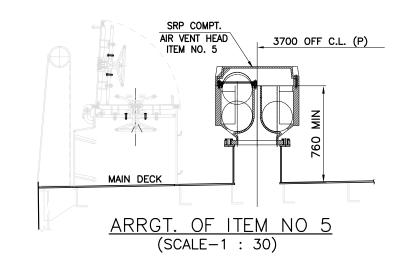

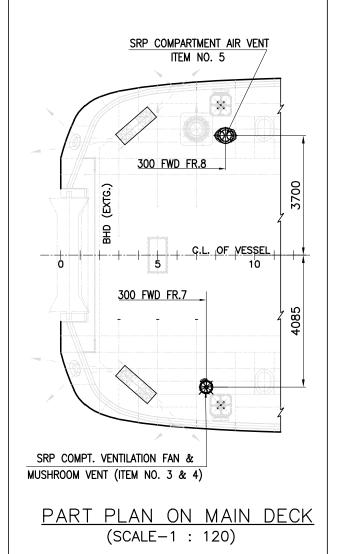

### REF. DWG: -

GENERAL ARRANGEMENT

2. HULL CONSTRUCTION-BLOCK 5

3. VENTILATION FAN DETAILS (AXIAL FLOW FAN FOR MARINE USE)

DWG. NO. 01/22-D01

DWG. NO. 01/22-H255

S.R.P. COMPARTMENT VENTILATION FAN TYPE: CZF-35B S.R.P COMPARTMENT CLOSING DEVICE MUSHROOM VENT

TYPE : C-350, CB/T295-2000

S.R.P. COMPARTMENT AIR VENT HEAD TYPE: TFM-350

### NOTES:-

- 1. BEFORE FABRICATING FOUNDATION, YARD IS ADVISED TO CROSS-CHECK DRAWING NO. AND REVISION NO. OF VENDOR'S CONFIRMED/BINDING DRAWING WITH THE DETAILS STATED ON FOUNDATION DRAWING. CORRECTIVE MEASURES TO BE TAKEN FOR ANY DEVIATION.
- 2. BOLTING HOLES POSITION ON SEAT TO MATCH VENDOR'S FOOTPRINT.
- 3. THE TOP OF THE SEAT/SUPPORT IS TO BE KEPT PARALLEL TO THE BASE LINE.

PROJECT: SCALE : 1 : 30 DRAWN: garai 70T BOLLARD PULL TUG CLIENT'S HULL NO. : NB786 & NB787 CHECKED : NAV TITLE : SRP COMPT. VENT FAN & MUSHROOM VENT FND. DATE: 10.06.2024 BUILDER: KHULNA SHIPYARD LIMITED, BANGLADESH APPROVED BY CLASS DATED: OWNER: APPROVED BY OWNER DATED: PAYRA PORT AUTHORITY, BANGLADESH

DESIGNER:

NAVNAUTIK PTE LTD NAVAL ARCHITECTS, MARINE ENGINEERS & MARINE SURVEYORS.


540 SIMS AVENUE #02-04 SIMS AVE CENTRE SINGAPORE 387603

TEL: +65 67417220 FAX: +65 67417219

E-mail: NPL@navnautik.com or navnautik@gmail.com

01/22-H96 DRG. NO.: (SHT 1 OF 1 )

REV: 0

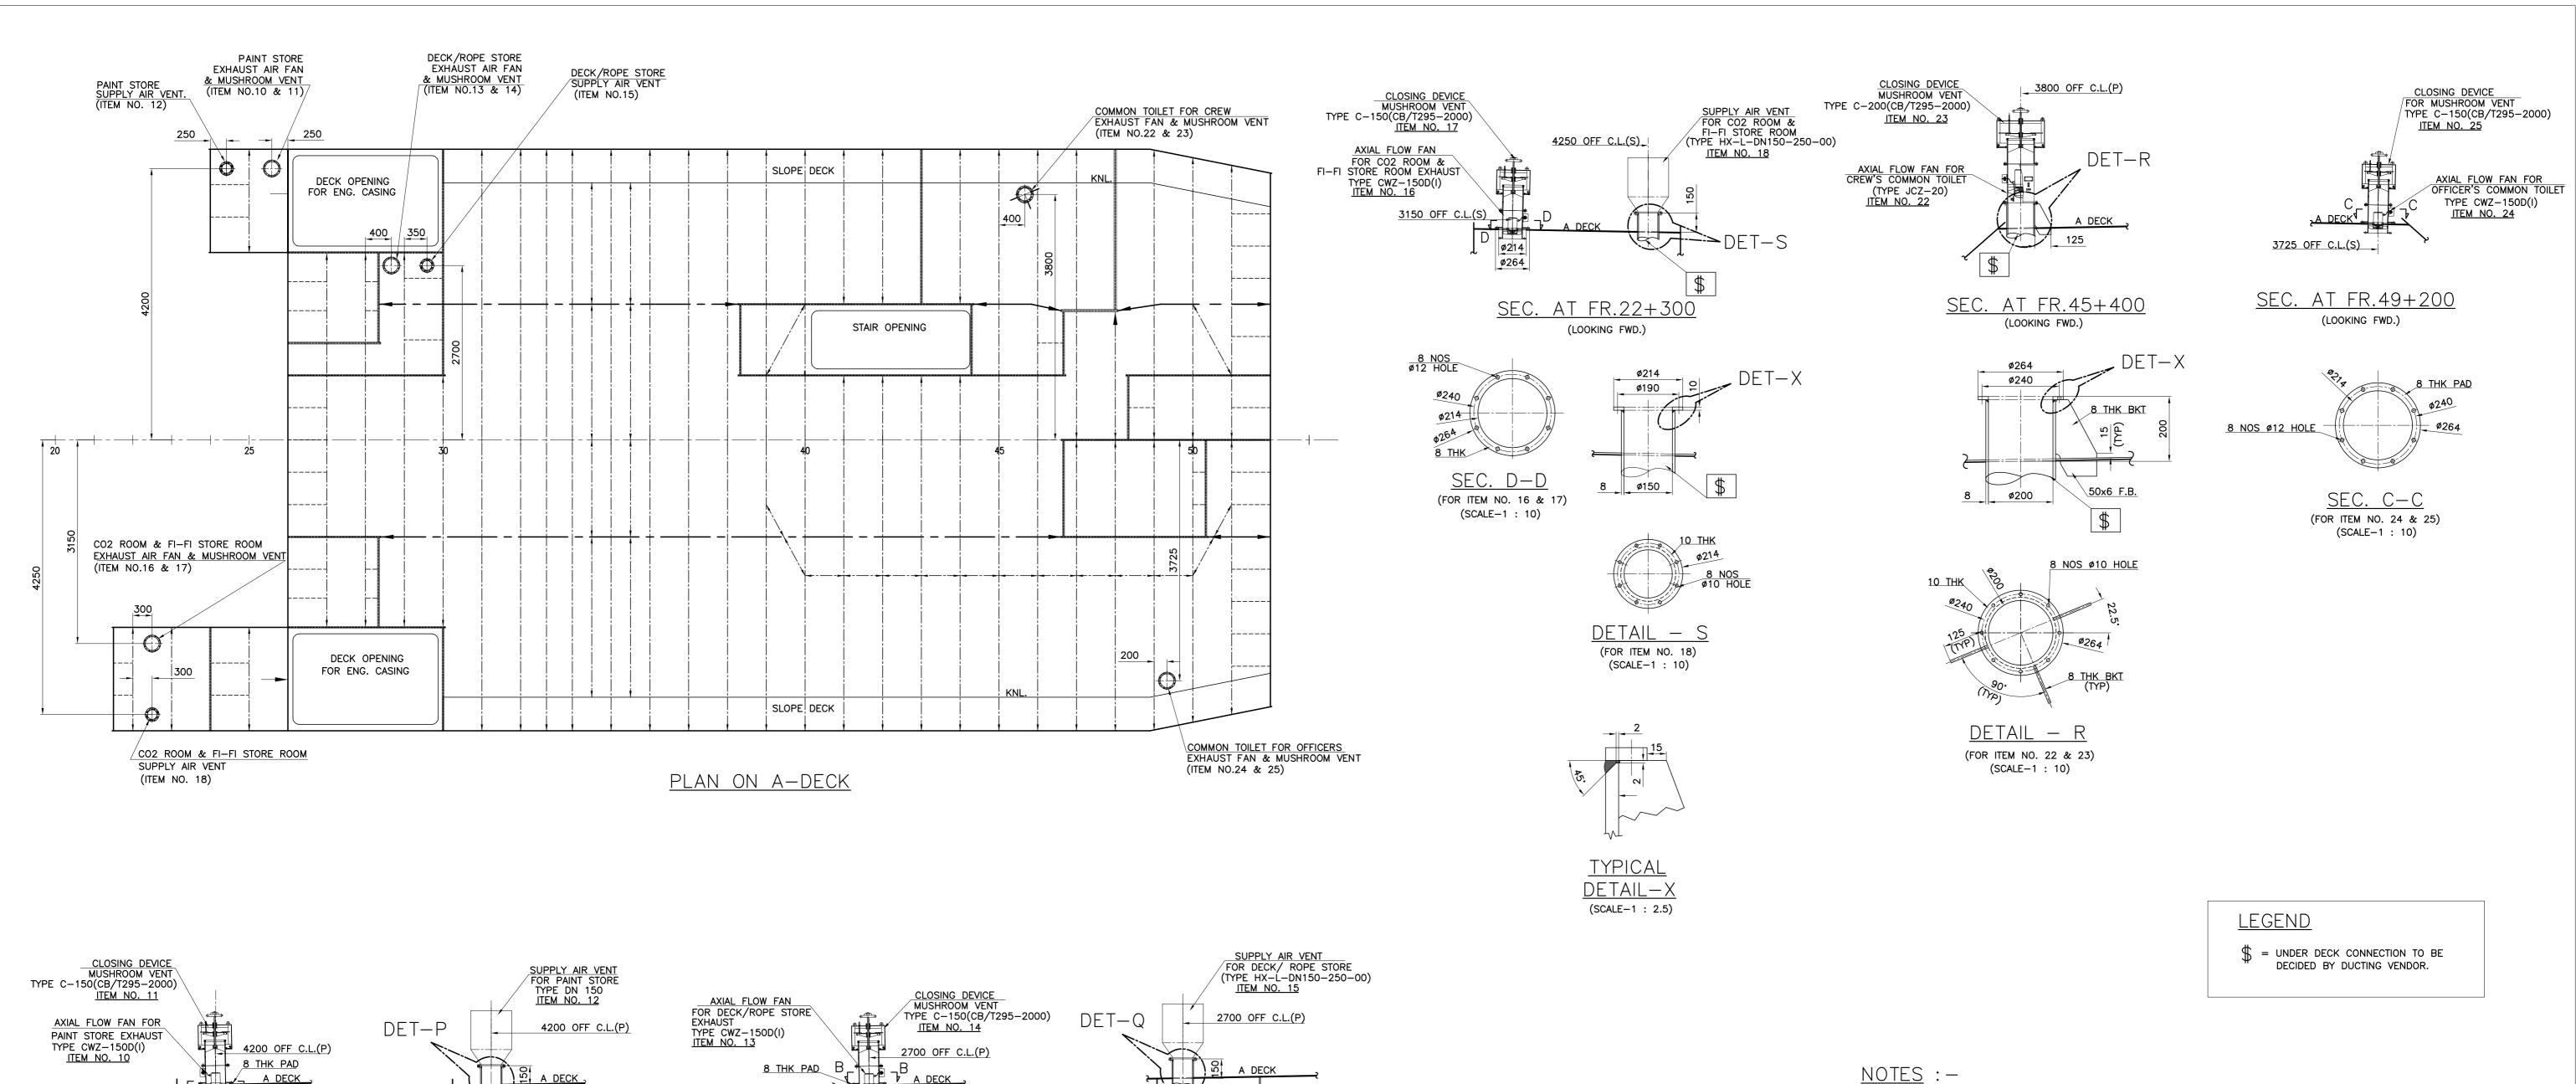

- 1. BEFORE FABRICATING FOUNDATION, YARD IS ADVISED TO CROSS-CHECK DRAWING NO. AND REVISION NO. OF VENDOR'S CONFIRMED/BINDING DRAWING WITH THE DETAILS STATED ON FOUNDATION DRAWING. CORRECTIVE MEASURES TO BE TAKEN FOR ANY DEVIATION.
- 2. BOLTING HOLES POSITION ON SEAT TO MATCH VENDOR'S FOOTPRINT.
- 3. THE TOP OF THE SEAT/SUPPORT IS TO BE KEPT PARALLEL TO THE BASE LINE.

REF. DWG: -

- 1. GENERAL ARRANGEMENT
- 2. HOUSES ON MAIN DECK
- 3. VENTILATION FAN DETAILS (AXIAL FLOW FAN FOR MARINE USE)

DWG. NO. 01/22-D01

DWG. NO. 01/22-H14

PAINT STORE VENTILATION FAN TYPE : CWZ-150D(I) MUSHROOM VENT (PAINT STORE) TYPE : C-150, CB/T295-2000 SUPPLY AIR VENT (PAINT STORE) TYPE: HX-L-DN50-250-00 DECK/ROPE STORE VENTILATION FAN TYPE : CWZ-150D(I) MUSHROOM VENT (DECK/ROPE STORE) TYPE : C-150, CB/T295-2000 SUPPLY AIR VENT (DECK/ROPE STORE) TYPE: HX-L-DN50-250-00 CO2 RM & FIFI STORE VENTILATION FAN TYPE : CWZ-150D(I) MUSHROOM VENT (CO2 RM & FIFI STORE) TYPE : C-150, CB/T295-2000 SUPPLY AIR VENT (CO2 RM & FIFI STORE) TYPE: HX-L-DN50-250-00 COMMON TOILET FOR CREW VENTILATION FAN TYPE : JCZ-20 MUSHROOM VENT (COMMON TOILET FOR CREW) TYPE: C-200, CB/T295-2000 COMMON TOILET FOR OFFICER VENTILATION FAN TYPE : CWZ-150D(I) MUSHROOM VENT (COMMON TOILET FOR OFFICER) TYPE: C-150, CB/T295-2000

REV	DESCRIPTION OF ALTERATION	DATE	BY	REV	DESCRIPTION OF ALTERATION	DATE	BY	

SEC. AT FR.24+250

(LOOKING FWD.)

ø190

8 ø150

DETAIL - P

(FOR ITEM NO. 12)

`(SCALE-1 : 10) ´

ø264

SEC. AT FR.25+350

(LOOKING FWD.)

(FOR ITEM NO. 10 & 11)

(SCALE-1 : 10)

8 THK PAD

- 1. ALL STEEL MATERIAL ARE BV GRADE—A UNLESS STATED OTHERWISE. 2. YARD IS ADVISED NOT TO FABRICATE UNTIL DWG. IS APPROVED BY CLASS.
- 3. "HOLD" MARK ON DWG. INDICATES CLASS APPROVAL PENDING.

SEC. AT FR.29+350

ø190

DETAIL - Q

(FOR ITEM NO. 15)

(SCALE-1 : 10)

(LOOKING FWD.)

DET-X

SEC. AT FR.28+400


SEC. B-B

(FOR ITEM NO. 13 & 14)

(SCALE-1 : 10)

(LOOKING FWD.)

DRAWN : Partha	SCALE : 1 : 25	PROJECT	: 70T BOLLARD PULL TUG	DESIGNER :		
CHECKED : NAV	CLIENT'S HULL NO. : NB786 & NB787	TITLE :			UTIK PTE LTD ECTS, MARINE ENGINEE	
DATE : 10.06.24		BUILDER	VENT FAN FOUNDATION ON 'A' DECK	- 540 SIMS AVENUE #02-04 SIMS AVE	TEL: +65	5 67417220 5 67417219
APPROVED BY CLASS DA	TED :	OWNER	KHULNA SHIPYARD LIMITED, BANGLADESH	SINGAPORE 387603 E-mail: NPL@navn	nautik.com or navnautik@gmail.c	com
APPROVED BY OWNER DATED :			PAYRA PORT AUTHORITY, BANGLADESH	DRG. NO.:	01/22-H97 (SHT 1 OF 1 )	REV :0

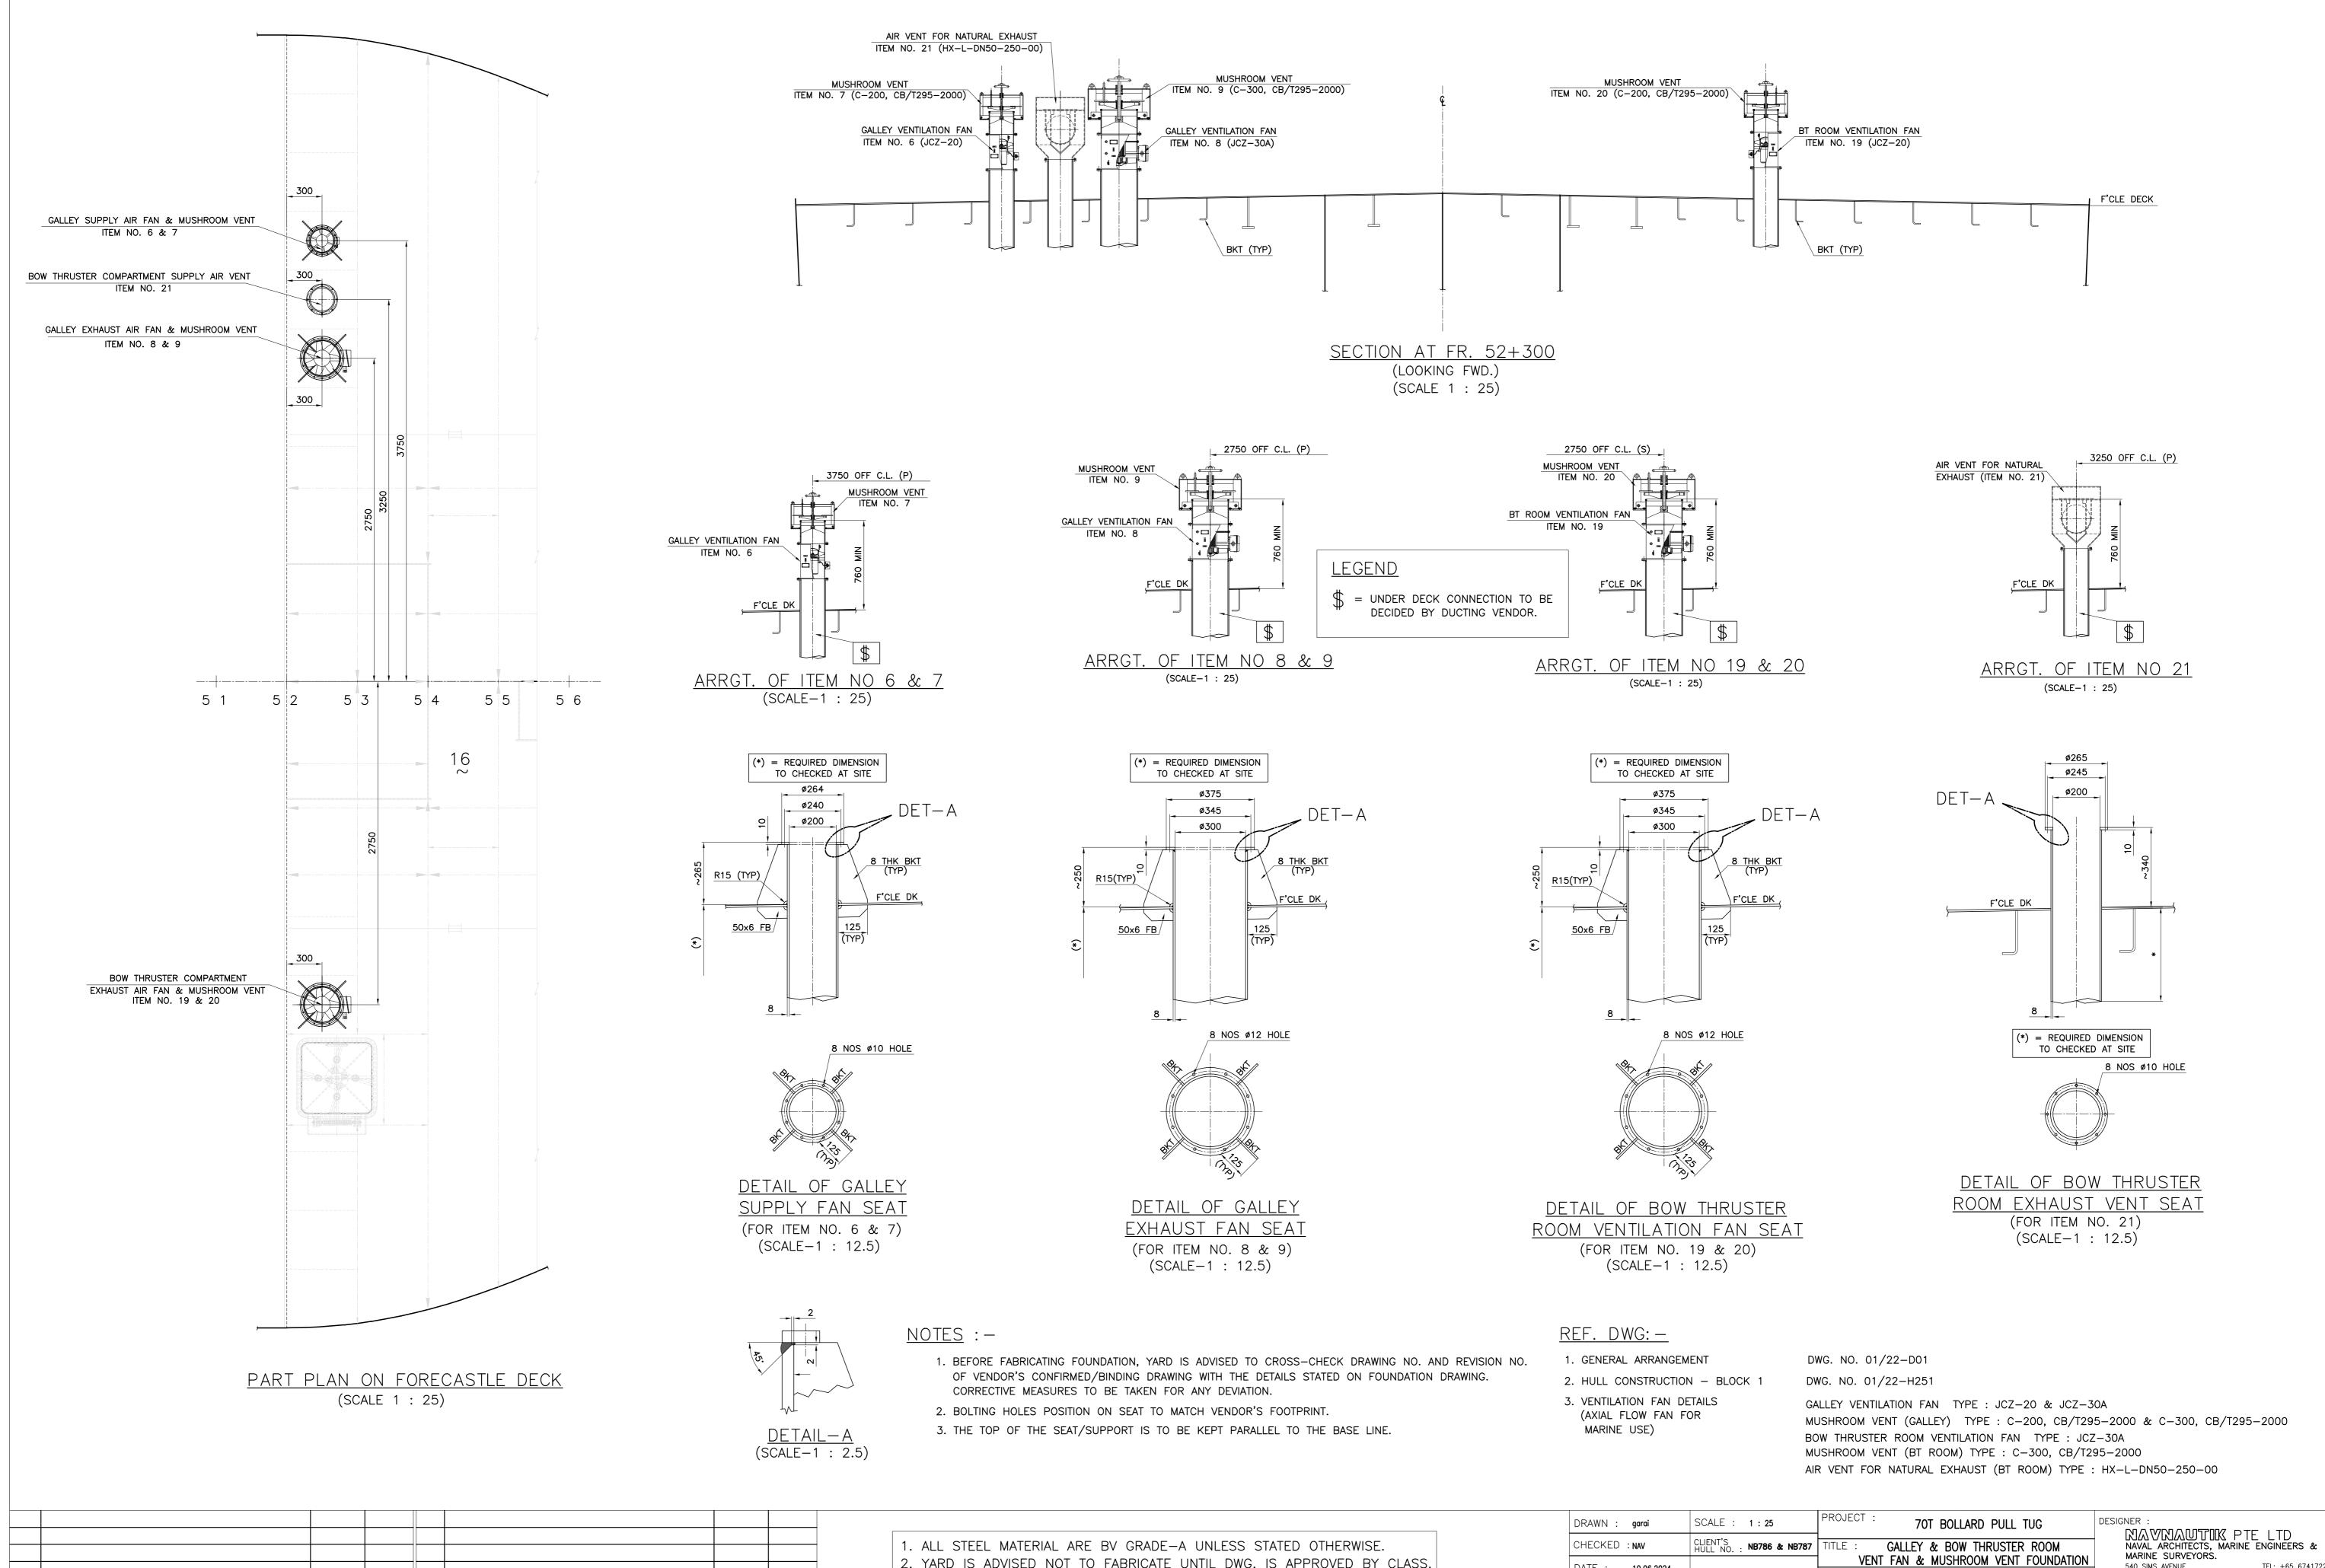

CHECKED: NAW CLIENT'S NB786 & NB787 TITLE: GALLEY & BOW THRUSTER ROOM AWARINE ENGINEERS & NAW MARINE SURVEYORS.

2. YARD IS ADVISED NOT TO FABRICATE UNTIL DWG. IS APPROVED BY CLASS.

3. "HOLD" MARK ON DWG. INDICATES CLASS APPROVAL PENDING.

REV DESCRIPTION OF ALTERATION DATE BY

BUILDER: NAW MUSHROOM VENT FOUNDATION BANGLADESH

APPROVED BY OWNER DATED:

1. ALL STEEL MATERIAL ARE BV GRADE—A UNLESS STATED OTHERWISE.

2. YARD IS ADVISED NOT TO FABRICATE UNTIL DWG. IS APPROVED BY CLASS.

3. "HOLD" MARK ON DWG. INDICATES CLASS APPROVAL PENDING.

APPROVED BY OWNER DATED:

TITLE: GALLEY & BOW THRUSTER ROOM WARINE ENGINEERS & NAVINUE FOUNDATION BANGLADESH


NAVIN ABRIGE BV GRADE—A UNLESS STATED OTHERWISE.

2. YARD IS ADVISED NOT TO FABRICATE UNTIL DWG. IS APPROVED BY CLASS.


3. "HOLD" MARK ON DWG. INDICATES CLASS APPROVAL PENDING.

APPROVED BY OWNER DATED:


TO SOLUTION OF ALTERATION DATE OF 1 DATE OF 1

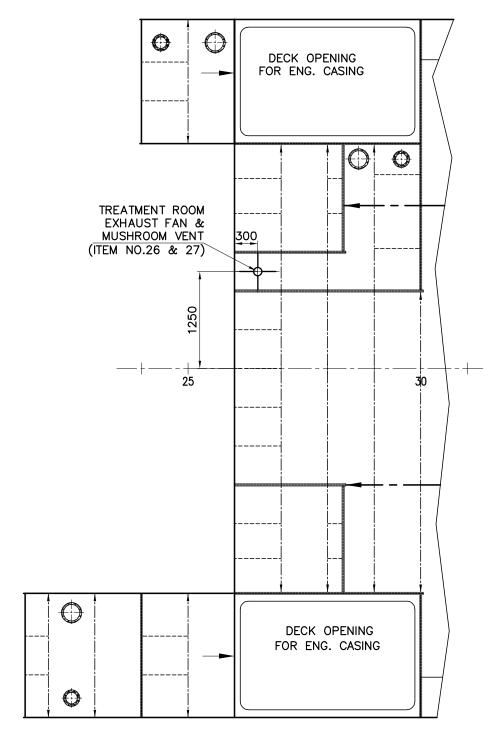


PART PLAN ON A-DECK

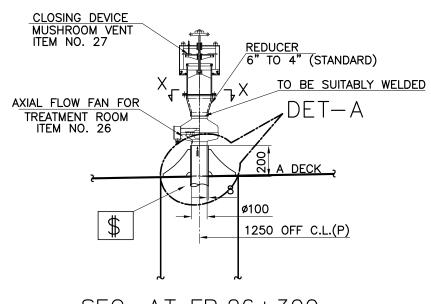

SEC. AT FR.26+300 (LOOKING FWD.)

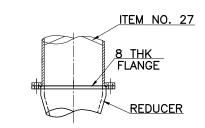


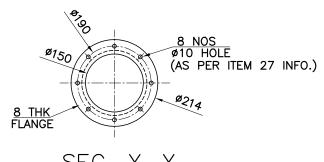

 $\frac{\text{SEC. }X-X}{\text{(FOR ITEM NO. 26 & 27)}}$  (SCALE-1:10)

### LEGEND

= UNDER DECK CONNECTION TO BE DECIDED BY DUCTING VENDOR.

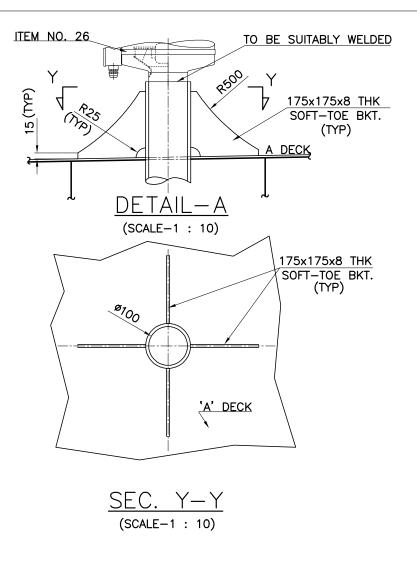

### NOTES:-

- 1. BEFORE FABRICATING FOUNDATION, YARD IS ADVISED TO CROSS—CHECK DRAWING NO. AND REVISION NO. OF VENDOR'S CONFIRMED/BINDING DRAWING WITH THE DETAILS STATED ON FOUNDATION DRAWING. CORRECTIVE MEASURES TO BE TAKEN FOR ANY DEVIATION.
- 2. BOLTING HOLES POSITION ON SEAT TO MATCH VENDOR'S FOOTPRINT.
- 3. THE TOP OF THE SEAT/SUPPORT IS TO BE KEPT PARALLEL TO THE BASE LINE.

### REF. DWG: -

1. GENERAL ARRANGEMENT

2. HOUSES ON MAIN DECK

3. VENTILATION FAN DETAILS (AXIAL FLOW FAN FOR MARINE USE) DWG. NO. 01/22-D01 DWG. NO. 01/22-H14

TREATMENT ROOM TOILET VENTILATION FAN TYPE : EK100M

MUSHROOM VENT (TREATMENT ROOM)
TYPE: C-150, CB/T295-2000

PROJECT : DESIGNER : SCALE : 1 : 25 DRAWN: Partha 70T BOLLARD PULL TUG NAVNAUTIK PTE LTD NAVAL\_ARCHITECTS, MARINE ENGINEERS & CHECKED : NAV NB786 & NB787 TITLE : MARINE SURVEYORS. TREATMENT ROOM EXHAUST FAN FOUNDATION 540 SIMS AVENUE TEL: +65 67417220 DATE: 18.06.24 BUILDER: #02-04 SIMS AVE CENTRE SINGAPORE 387603 FAX: +65 67417219 KHULNA SHIPYARD LIMITED, BANGLADESH APPROVED BY CLASS DATED: E-mail: NPL@navnautik.com or navnautik@gmail.com OWNER: 01/22-H99 DRG. NO.: REV: 0 APPROVED BY OWNER DATED: PAYRA PORT AUTHORITY, BANGLADESH (SHT 1 OF 1 )